


NOTES:

1. REFER TO DRAWING E01 FOR LEGEND AND GENERAL NOTES
2. POWER SUPPLY FROM DB-G-G LOCATED ON GROUND LEVEL. PROVIDE CONDUITS CAST IN SLAB FROM DISTRIBUTION BOARD TO THE LUMINAIRES AND MOTION DETECTORS.
3. PROVIDE CONDUITS CAST IN SLAB FROM FDCIE/EWCIE LOCATED ON GROUND LEVEL TO THE SMOKE DETECTORS AND SPEAKERS.

THE COPYRIGHT OF THIS DRAWING REMAINS THE PROPERTY OF THE ELECTRICAL DESIGN GROUP.

USE FIGURED DIMENSIONS IN PREFERENCE TO SCALE.

ALL DIMENSIONS TO BE VERIFIED ONSITE.

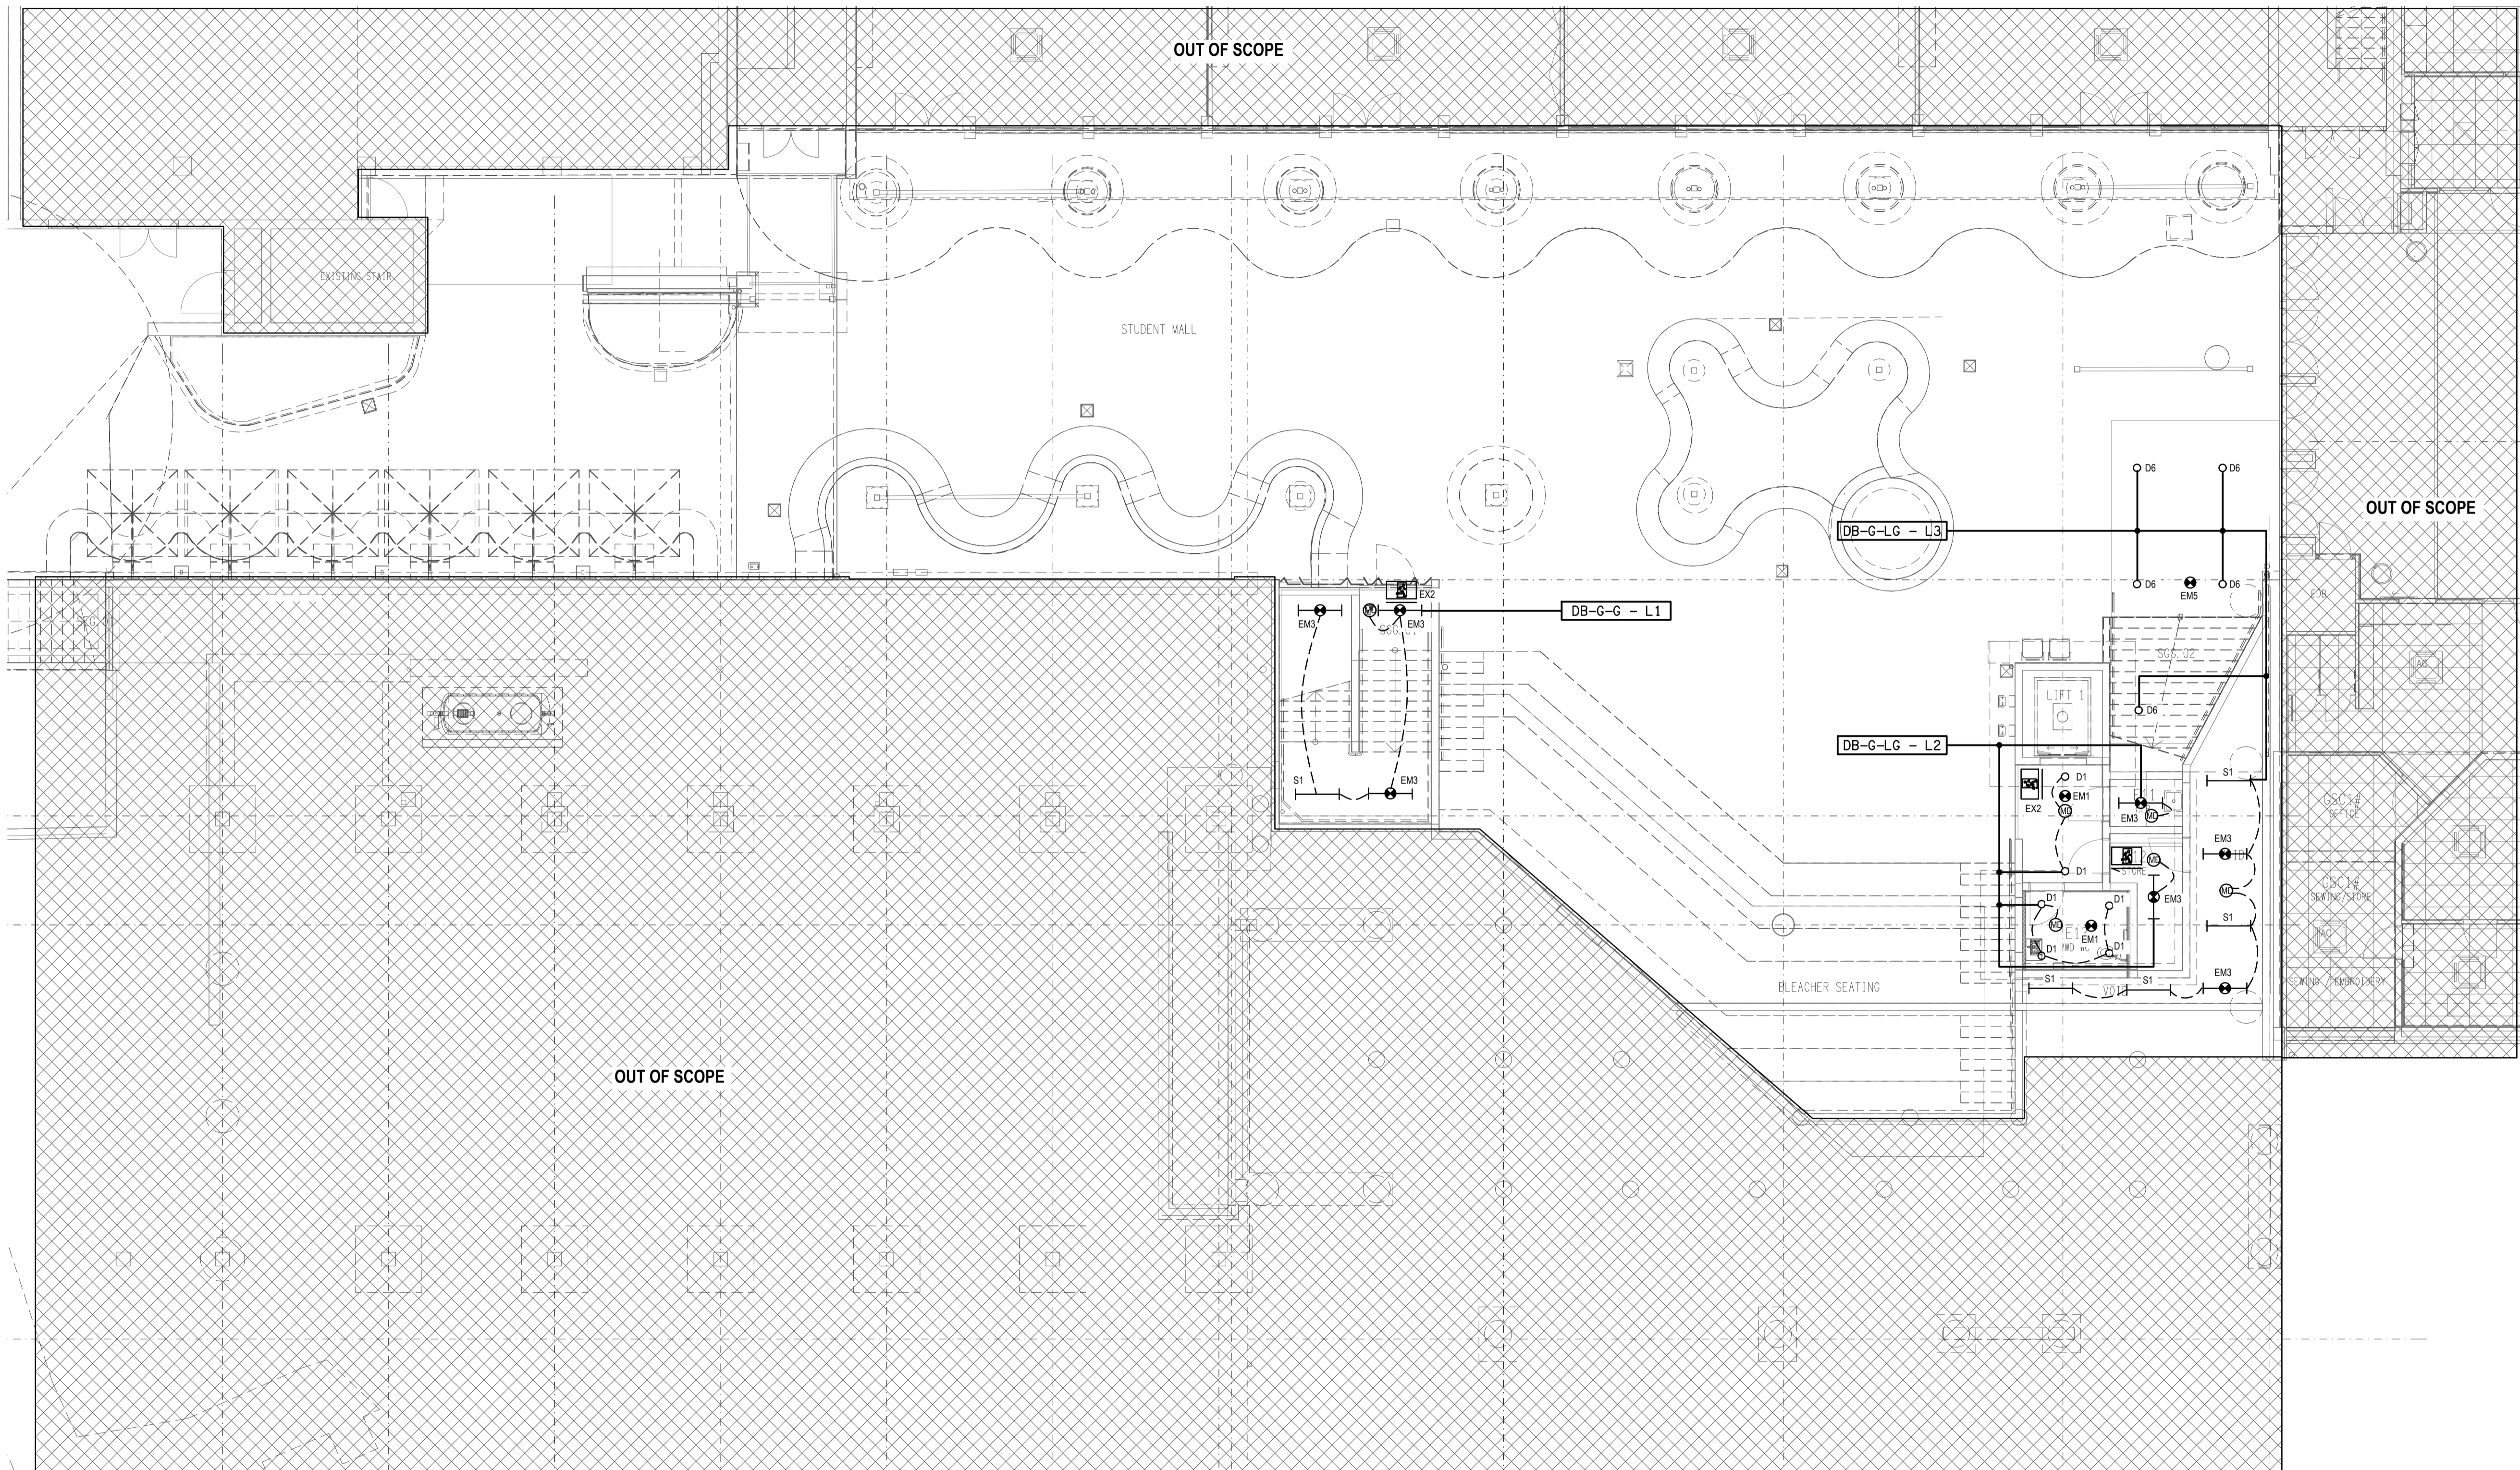

C	INFORMATION	11/12/2023
REV:	DESCRIPTION:	DATE:

ELECTRICAL DESIGN GROUP
ELECTRICAL BUILDING SERVICES CONSULTANTS

BRISBANE: P.O. Box 15 Sherwood Qld 4075
Phone: (07) 3278 4375
Email: brisbane@edg.net.au
Web: www.edg.net.au

ELECTRICAL DESIGN GROUP BRISBANE / TRADING AS:
PTY LTD ACN 092 710 793 ELECTRICAL DESIGN GROUP

PROJECT:
**LOURDES HILL COLLEGE
STAGE 1**

SITE ADDRESS:
86 HAWTHORNE ROAD,
HAWTHORNE, QUEENSLAND

SCALE: 1:100 SHEET SIZE: AT A1

DRAWING TITLE:
**ELECTRICAL SERVICES
STAGE 1A LOWER GROUND
REFLECTED CEILING PLAN**

PROJECT NO. DRAWING NO. REVISION:
C3134a E07 C